Agenda Item	7.8
Report No	PLS-13-23

HIGHLAND COUNCIL

Committee: South Planning Applications Committee

Date: 08 February 2023

Report Title: 22/03922/FUL: The Highland Council

Town House car park, Castle Street, Inverness

Report By: Area Planning Manager – South

Purpose/Executive Summary

Description: Change of use and alteration of former public toilet building to form

Sustainable Energy Centre, with associated improvement of adjacent

public realm

Ward: 14 – Inverness Central

Development category: Local

Reason referred to Committee: Planning Manager's discretion, Levelling-Up Funding Project

All relevant matters have been taken into account when appraising this application. It is considered that the proposal accords with the principles and policies contained within the Development Plan and is acceptable in terms of all other applicable material considerations.

Recommendation

Members are asked to agree the recommendation to **GRANT** the application as set out in section 11 of the report

1. PROPOSED DEVELOPMENT

- 1.1 The project at the Town House car park is part of Highland Council's Inverness Zerocarbon cultural regeneration and levelling-up programme.
- 1.2 The Town House car park toilet-block is proposed for partial demolition (of the upper level) and the creation of a 2-storey energy centre (air-source heat pumps; ASHP) to provide sustainable heating to the Inverness Castle re-development. The building will be slightly higher than existing and will be clad in an aluminium louvred-panels to allow airflow to all sides and roof. Associated with this, the public realm to the existing stairs and adjacent areas will be upgraded. The lower level is accessed directly from the car park, the upper level from Castle Wynd; the site and adjacent areas are all in the ownership of Highland Council.
- 1.3 Pre-Application Consultation: no formal pre-application advice; Inverness Castle team discussions.
- 1.4 Supporting Information: ASHP data; Design Statement; External Lighting Design; External Views; Noise Impact Assessment.
- 1.5 Variations: Design amendments to reduce the height of the proposal; amended drawings received 06.01.2023.

2. SITE DESCRIPTION

- 2.1 The existing building is a utilitarian two storey block, which straddles Castle Wynd on the west and the Castle Street car park on the east, its upper floor being accessible from Castle Wynd and its lower floor being accessible from the Castle Street car park. At its lower level, the building currently accommodates a small storage space, office and toilet, but is otherwise given over to an infilled solum space. At its upper level the building is laid out as separate male and female public toilets, which are dated and out of commission. It is built primarily of masonry, with rendered block work walls with some stone cladding to the upper level, concrete floors and a flat roof punctuated by roof lights. In the past, the building has had problems with members of the public accessing the flat roof area, which has resulted in metal railings being added to some of the perimeter of the building. The building is set off the southern gable of Inverness Townhouse, and the space between the two is occupied by a functional but otherwise uninspiring public stair, which does not encourage footfall from Castle Street onto Castle Wynd, or vice versa.
- 2.2 The site is within the Inverness Riverside Conservation Area, as well as the setting of the A-listed Inverness Castle and Townhouse; there are also B-listed buildings opposite on the eastern side of Castle Street (No.s 35-51 odds). This is therefore a very sensitive site in terms of built and cultural heritage. The existing building is however of very low architectural value, and its redevelopment is (in principle) welcomed.

3. PLANNING HISTORY

3.1 11.11.2022 22/04025/CON Demolition of upper level of

toilet block

Conservation Area Consent Granted

4. PUBLIC PARTICIPATION

4.1 Advertised: Section 65 - Affecting Conservation Area; Unknown Neighbour

Date Advertised: 23.09.2022

Representation deadline: 14.10.2022

Timeous representations: 1

Late representations: 0

- 4.2 Material considerations raised are summarised as follows:
 - a) Quality of design
 - b) Quality of materials
 - c) Impact on the setting of the Castle
- 4.3 All letters of representation are available for inspection via the Council's eplanning portal which can be accessed through the internet www.wam.highland.gov.uk/wam.

5. CONSULTATIONS

- 5.1 Crown and City Centre Community Council: No response received.
- 5.2 **Historic Environment Team Archaeology**: "Although this area may have been altered significantly by development in the past century or so, it remains within an area of archaeological potential. This has been evidenced by early prehistoric deposits found at a considerable depth below the existing ground surface during development in the immediate area. As such, any areas where ground-breaking is required (below current hard surfaces, or following any proposed demolition), should be carried out under archaeological monitoring.

While the risk of encountering buried deposits is not such as to warrant a full excavation, it is important that the nature and extent of any features is identified and recorded before destruction. Site clearance work should be done under archaeological supervision so that, if necessary, any recording can be done without causing undue delay or inconvenience for the development.

This work is relevant for any initial site clearance or groundworks required and any associated works, services or access. A controlled topsoil strip will ensure that that any features uncovered will be adequately recorded, while causing minimum delay to the development. The applicant will need to engage the services of a professional archaeologist. The work will result in a report which will be lodged in the Highland Historic Environment Record (HER), where it may be consulted for research. Archaeological contractors are asked to send copies of such reports direct to us. We will advise you of receipt and confirm that they form a satisfactory record."

- 5.3 Environmental Health Contaminated Land Unit: "Having checked our database, historical Ordnance Survey maps and aerial photos, there does not appear to be a potential source of contamination onsite. The Highland Council's property database for this site has an Asbestos Management Survey dated to 2013 which did not record any suspected asbestos containing material based on a visual inspection of accessible areas. Therefore, further information is not required to support the application."
- 5.4 **Environmental Health**: "It is understood that the application involves the installation and operation of an array of Air Source Heat Pumps (ASHP) with associated infrastructure, to provide energy for the refurbished Castle Building. There is the potential for noise from this development to impact on the amenity of nearby sensitive receptors.

As requested in previous correspondence, a noise impact assessment has been undertaken and a report provided (22568-R01-A, dated 20th January 2023) The report assumes a worst-case scenario of all thirteen ASHP operating simultaneously, which is unlikely to be the case. It confirms that, unattenuated, the noise from the proposed development has the potential to impact on the amenity of nearby receptors. Mitigation measures (comprising a noise barrier) are proposed to be incorporated in the development to address this issue and to reduce noise levels.

The report presents a measured night-time background sound level of 37dB and predicts that, outside the nearest noise sensitive receptor, the noise levels from the development (without attenuation) will have a rating level of 47dBA (which includes an additional penalty for the tonality and intermittency of the sound of 5dB). The report confirms that this is 10dB above the background sound level and, in accordance with BS4142, this is likely to be an indication of a significant adverse impact.

Following the installation of a noise barrier, the report predicts noise levels to reduce by 6dB, resulting in a rating level of 41dBA outside the nearest dwellings. This is 4dB above the measured background level and, in accordance with BS4142, this is below the difference (5dB) at which there is likely to be an adverse impact.

It is noted that this predicted external rating level includes a subjective penalty of 5dB for the tonality and intermittency. This appears a reasonable assumption, however, should the actual noise happen to have more pronounced characteristics, a higher penalty could be required and additional noise mitigation may be necessary to meet he recommended Condition.

It is noted that the proposed noise barrier does not extend to the castle-side and the noise from the proposed development may have an impact on this area. The noise assessment has not addressed this aspect.

Based on the information provided, and given that the report has assumed a 'worst-case' scenario, this Service has no objection to the development, subject to the following Condition being attached."

6. DEVELOPMENT PLAN POLICY

The following policies are relevant to the assessment of the application

6.1 Highland Wide Local Development Plan 2012

- 28 Sustainable Design
- 29 Design Quality and Place-making
- 30 Physical Constraints
- 31 Developer Contributions
- 34 Settlement Development Areas
- 57 Natural, Built and Cultural Heritage
- 58 Protected Species
- 66 Surface Water Drainage
- 67 Renewable Energy Developments
- 68 Community Renewable Energy Developments
- 72 Pollution
- 73 Air Quality
- 77 Public Access

6.2 Inner Moray Firth Local Development Plan 2015

No site-specific policies

6.3 Inner Moray Firth Proposed Local Development Plan 2022

No site-specific policies

6.5 Highland Council Supplementary Planning Policy Guidance

Highland Historic Environment Strategy (Jan 2013)

Highland's Statutorily Protected Species (March 2013)

Highland Renewable Energy Strategy and Planning Guidelines (May 2006)

Inverness City Centre Development Brief (Feb 2018)

Standards for Archaeological Work (March 2012)

Sustainable Design Guide (Jan 2013)

7. OTHER MATERIAL POLICY CONSIDERATIONS

7.1 Scottish Government Planning Policy and Guidance

Scottish Planning Policy (as amended December 2020)

Revised Draft National Planning Framework 4

Designing Streets

Creating Places

8. PLANNING APPRAISAL

8.1 Section 25 of the Town and Country Planning (Scotland) Act 1997 requires planning applications to be determined in accordance with the development plan unless material considerations indicate otherwise.

8.2 Section 64 of the Planning (Listed Buildings and Conservation Areas) (Scotland) Act 1997 states that, the Planning Authority must pay special attention to the desirability of preserving or enhancing the character or appearance of the Inverness (Riverside) Conservation Area.

Determining Issues

8.3 This means that the application requires to be assessed against all policies of the Development Plan relevant to the application, all national and local policy guidance and all other material considerations relevant to the application.

Planning Considerations

- 8.4 The key considerations in this case are:
 - a) compliance with the development plan and other planning policy
 - b) siting, layout and design
 - c) impact on the setting of Inverness Castle and Town House
 - d) impact upon the Inverness Riverside Conservation Area
 - e) noise impacts upon surrounding amenity
 - f) landscaping to the public realm.

Development plan/other planning policy

- 8.5 The introduction of a new building to this sensitive context, within the city-centre, raises many issues. Policies 28 Sustainable Design, 29 Design Quality and Place-making and 34 Settlement Development Areas, require that proposals demonstrate sensitive siting and high-quality design in-keeping with local character and the historic environment. It is worth noting that the car park is a mixed-use development site (linked to the Castle and Bridge Street) within the Inverness City Centre Development Brief, which could result in the energy centre being absorbed into a larger development in the future.
- 8.6 The site is within the Inverness Riverside Conservation Area, as well as the setting of the A-listed Inverness castle and Town House; there are also B-listed buildings opposite on the eastern side of Castle Street (No.s 35-51 odds). There is a requirement to judge proposals in terms of their impact upon the natural, built and cultural heritage features identified by Policy 57 of the HwLDP. This policy states that developments are suitable where they can be demonstrated not to have an unacceptable impact on the protected amenity and heritage resource.
- 8.7 Subject to the proposal having no detrimental impact on the built and natural environment in terms of siting, layout and design; as well as on surrounding amenity, the proposal would comply with the Development Plan.

Siting, layout and design

8.8 The site for this energy centre has been chosen for its proximity to Inverness Castle, which it is servicing, and because there was a redundant building which could be

- sustainably re-developed. There are three elements of the design for consideration: the building form, the building skin and the public realm proposals.
- 8.9 The existing building form is a rectilinear plan set perpendicular to the South gable of Inverness Town House, with its back against the retaining wall that forms the edge of Castle Wynd. The building does not meet the retained landform at its South end, leaving a wedge-shaped void and has an expanse of flat roof, which serves to exaggerate the building's scale when looked at from the castle esplanade or when approached from the top of Castle Wynd. The proposed building is instead directly influenced by the surrounding context. Firstly, the South end of the building is realigned to follow the existing retaining-wall, filling in the existing wedge-shaped void and connecting the building, literally, to the sloping grass embankment. The expansive flat roof is then replaced with a geometrically faceted pitched roof, which slopes in three directions with the gradient of each pitch precisely aligned with the slope of the topography on each elevation. The rise and fall of the roof pitches following the ground line serves to create a strong and natural relationship between the building and its context whilst creating a dynamic form that, although taller at its high points than the existing roof, makes the building appear far smaller from the key surrounding viewpoints. The roof-height matches the existing on the east/car park side but rises to points 2.1/33.2m higher left/right on the western/Castle Wynd side. In strengthening the building's relationship to the landscape, the sense of the building acting as an anchor or gateway to the wider Castlehill site is also reinforced.
- 8.10 The building skin is intended to have a modulated and faceted surface, allowing through airflow and giving a deeply textured appearance. The building will have an ordered façade split into equal bays with a vertical emphasis, each approximately two metres wide. A saltire grid is then applied to each bay, creating elongated rhomboid voids into which bespoke cladding elements are inserted; this pattern is reflective of the ceiling structure of the Castle's new link building. In this way, the two developments will be inherently related and should read as part of an architectural family. The intention is for the bespoke cladding elements to be coloured in subtly different tones of pinks, reds and greys, so as to give a similar visual effect to the different tones in the natural stone of the Castle and Town House buildings that stand either side. Further variation is then introduced through the degree to which each cladding element is 'open'. In order to provide free air floor to the ASHP equipment, the cladding elements are designed in four permutations: closed, 75% open, 50% open and 25% open. This is achieved by taking the rhomboid shape of each cladding element and pulling the centre point outwards to create a shallow pyramid. Two facets of the pyramid are then removed to provide an open area and the centre point is moved up or down to create less or more free area accordingly. As well as providing free air flow, the variations in the pyramid form and the percentage of open area serve to animate the façade and provide glimpsed views through to the workings behind whilst also enhancing the effect of a honed or tooled stone or jewel mentioned above.
- 8.11 Ultimately, the acceptability of this proposal lies in the quality, detailing and colour of the metal cladding panels; a condition is added for a full-scale sample to be provided on site, for written approval.

Impact on the setting of Inverness Castle and Town House

8.12 The proposed re-development of the toilet-block has chosen a contemporary form and materiality, a principle we generally support, even in heritage-sensitive locations. As noted above, much rests on the exact appearance and quality of the cladding, which will define its visual impacts and suitability within this context. While both the Castle and Town House are the highest level of listing (Category A), they are both very large and townscape-dominant buildings; as such, we would not expect the relatively subordinate scale of the proposal to adversely affect their setting, even with a contemporary design and materiality. The same applied to the listed buildings opposite on Castle Street, which are less directly affected.

Impact upon the Inverness Riverside Conservation Area

8.13 As set out above, the modern design may not be visually consistent with the character and appearance of the heritage townscape, but it will hopefully add a level of innovation and interest which at the same time is not obtrusive.

Noise impacts upon surrounding amenity

- 8.14 The submitted Noise Impact Assessment has analysed the acoustic impacts arising from the ASHPs and machinery upon the surrounding environment, and in particular the closest residential accommodation (in the re-built building next to Chisholms), Consideration must also be given to pedestrians passing the energy centre on Castle Wynd.
- 8.15 The impacts upon surrounding amenity have, subject to condition, been found by Environmental Health to be acceptable. Condition 4 is added for the regulation of noise arising from the plant and associated machinery. Condition 5 is added for details of the acoustic mitigation within the proposed building.

Landscaping to the public realm

8.16 In delivering the energy centre, there is also an opportunity to dramatically improve the public realm, particularly within the Town House car park where a new pedestrian connection from Castle Street to Castle Wynd is proposed. This proposal will connect the new landscaping being delivered at Inverness Castle to the recently completed streetscape on lower Castle Wynd, carefully combining the material specifications of both schemes. The changes with the most impact will be the replacement of the existing staircase at the north end of the existing toilet block and the formation of a new pedestrian route along the South gable of the Town House. Currently, the existing staircase feels like a service access, which discourages public use and has no real resolution where it meets the car park, with users having to then navigate parking spaces and trafficked areas. As part of the proposals a new 3m wide straight stair with an intermediate landing is proposed. This new pedestrian area is 4.5m wide at the base of the stair, widening to 6.5m wide where it meets Castle Street introducing opportunities for people to linger and or congregate. To make the most of that opportunity, new tree planting, lighting and street furniture is proposed inclusive of public benches and covered and uncovered cycle storage, to promote active travel to and from the city centre. The surface finishes are specified to match

those of the recently completed streetscape works on lower Castle Wynd, which allows the public realm to feel as though it wraps itself around the Town House.

8.17 The proposed materials are a mixture of Caithness-stone paving and resin-bound gravel for the walkways, with Yorkshire stone facing to the new steps. Edgings/kerbs are in Scottish Whinstone, as are the bench facings which also have hardwood seats. New bollards, cycle-stands, planters and tree-grilles are in Corten^(R) steel; handrails are in stainless steel with integral lighting. Three new trees are proposed adjacent the car park, Tilia tomentosa (Silver Lime), and a new cycle-shelter.

Other material considerations

8.18 Public access/Core-Path: Castle Wynd is part of the Core Path Network but is already closed-off at its upper end by the Inverness Castle re-development site (under application 21/00100/FUL). A condition shall be added to update the Access Management Plan and signage already in-place, for the extended closure of Castle Wynd under this new proposal.

Non-material considerations

8.19 No non-material considerations have been raised in connection with the proposals.

Matters to be secured by Legal Agreement / Upfront Payment

8.20 None

9. CONCLUSION

- 9.1 The proposed energy centre is considered to be highly sustainable in its site and function, providing renewable energy to the Inverness Castle project as well as utilising a redundant existing building. The architecture is bold and dramatic, contemporary and innovative, but will ultimately rely on the final specification and design for the metal cladding panels (which require written approval via condition).
- 9.2 The proposed enhancements to the public realm are considered to be a significant improvement over the existing, with greatly improved materiality/detailing and better connectivity between Castle Street and Wynd.
- 9.3 All relevant matters have been taken into account when appraising this application. It is considered that the proposal accords with the principles and policies contained within the Development Plan and is acceptable in terms of all other applicable material considerations.

10. IMPLICATIONS

10.1 Resource: Not applicable

10.2 Legal: Not applicable

10.3 Community (Equality, Poverty and Rural): Not applicable

10.4 Climate Change/Carbon Clever: Not applicable

10.5 Risk: Not applicable

10.6 Gaelic: Not applicable

11. RECOMMENDATION

Action required before decision issued N

Notification to Scottish Ministers N

Conclusion of Section 75 Obligation N

Revocation of previous permission N

Subject to the above actions, it is recommended to **GRANT** the application subject to the following conditions and reasons:

Conditions and Reasons

1. In accordance with Section 58 of the Town and Country Planning (Scotland) Act 1997 (as amended), the development to which this planning permission relates must commence within THREE YEARS of the date of this decision notice. If development has not commenced within this period, then this planning permission shall lapse.

Reason: In accordance with Section 58 of the Town and Country Planning (Scotland) Act 1997 (as amended).

2. No development or work (including site clearance) shall commence until proposals for an archaeological watching brief to be carried out during site clearance and excavation works, has been submitted to, and approved in writing by, the Planning Authority. Thereafter, the watching brief shall be implemented as approved.

Reason: In order to protect the archaeological and historic interest of the site.

3. Full-scale samples of the proposed wall-cladding, with proposed colour-finish(es) shall be submitted on-site, and approved in writing by, the Planning Authority prior to the commencement of such development. Thereafter, work shall progress in accordance with these approved details.

Reason: In order to ensure quality of design/materiality and protect important elements of the existing character and amenity of the site.

4. All plant, machinery and equipment associated with the development, shall be so installed, maintained and operated such that the rating level of noise does not exceed 41dBA when measured outside any noise-sensitive property, in accordance with BS 4142:2014+A1:2019, Methods for rating and assessing industrial and commercial sound.

Reason: In the interests of surrounding amenity.

5. Details of proposed acoustic mitigation within the energy centre building shall be submitted, and approved in writing by, the Planning Authority prior to the commencement of such development. Thereafter, work shall progress in accordance with these approved details.

Reason: In the interests of surrounding amenity.

6. The existing Access Management Plan and informative signage for the temporary diversion of the Core Path IN19.55 (for the duration of the Inverness Castle works under 21/00100/FUL) shall be updated to include the extended closure of Castle Wynd (under this new proposal) and submitted to and agreed in writing by the Outdoor Access and Long Distance Route Manager. The provisions contained within the updated Access Management Plan shall thereafter be implemented.

Reason: In the interests of public amenity.

REASON FOR DECISION

All relevant matters have been taken into account when appraising this application. It is considered that the proposal accords with the principles and policies contained within the Development Plan and is acceptable in terms of all other applicable material considerations.

INFORMATIVES

Initiation and Completion Notices

The Town and Country Planning (Scotland) Act 1997 (as amended) requires all developers to submit notices to the Planning Authority prior to, and upon completion of, development. These are in addition to any other similar requirements (such as Building Warrant completion notices) and failure to comply represents a breach of planning control and may result in formal enforcement action.

- 1. The developer must submit a Notice of Initiation of Development in accordance with Section 27A of the Act to the Planning Authority prior to work commencing on site.
- 2. On completion of the development, the developer must submit a Notice of Completion in accordance with Section 27B of the Act to the Planning Authority.

Copies of the notices referred to are attached to this decision notice for your convenience.

Flood Risk

It is important to note that the granting of planning permission does not imply there is an unconditional absence of flood risk relating to (or emanating from) the application site. As per Scottish Planning Policy (paragraph 259), planning

permission does not remove the liability position of developers or owners in relation to flood risk.

Scottish Water

You are advised that a supply and connection to Scottish Water infrastructure is dependent on sufficient spare capacity at the time of the application for connection to Scottish Water. The granting of planning permission does not guarantee a connection. Any enquiries with regards to sewerage connection and/or water supply should be directed to Scottish Water on 0845 601 8855.

Local Roads Authority Consent

In addition to planning permission, you may require one or more separate consents (such as road construction consent, dropped kerb consent, a road openings permit, occupation of the road permit etc.) from the Area Roads Team prior to work commencing. These consents may require additional work and/or introduce additional specifications and you are therefore advised to contact your local Area Roads office for further guidance at the earliest opportunity.

Failure to comply with access, parking and drainage infrastructure requirements may endanger road users, affect the safety and free-flow of traffic and is likely to result in enforcement action being taken against you under both the Town and Country Planning (Scotland) Act 1997 and the Roads (Scotland) Act 1984.

Further information on the Council's roads standards can be found at: http://www.highland.gov.uk/yourenvironment/roadsandtransport

Application forms and guidance notes for access-related consents can be downloaded from:

http://www.highland.gov.uk/info/20005/roads and pavements/101/permits for wor king on public roads/2

Mud and Debris on Road

Please note that it an offence under Section 95 of the Roads (Scotland) Act 1984 to allow mud or any other material to be deposited, and thereafter remain, on a public road from any vehicle or development site. You must, therefore, put in place a strategy for dealing with any material deposited on the public road network and maintain this until development is complete.

Construction Hours and Noise-Generating Activities

You are advised that construction work associated with the approved development (incl. the loading/unloading of delivery vehicles, plant or other machinery), for which noise is audible at the boundary of the application site, should not normally take place outwith the hours of 08:00 and 19:00 Monday to Friday, 08:00 and 13:00 on Saturdays or at any time on a Sunday or Bank Holiday in Scotland, as prescribed in Schedule 1 of the Banking and Financial Dealings Act 1971 (as amended).

Work falling outwith these hours which gives rise to amenity concerns, or noise at any time which exceeds acceptable levels, may result in the service of a notice under

Section 60 of the Control of Pollution Act 1974 (as amended). Breaching a Section 60 notice constitutes an offence and is likely to result in court action.

If you wish formal consent to work at specific times or on specific days, you may apply to the Council's Environmental Health Officer under Section 61 of the 1974 Act. Any such application should be submitted after you have obtained your Building Warrant, if required, and will be considered on its merits. Any decision taken will reflect the nature of the development, the site's location and the proximity of noise sensitive premises. Please contact env.health@highland.gov.uk for more information.

Protected Species – Halting of Work

You are advised that work on site must stop immediately, and NatureScot must be contacted, if evidence of any protected species or nesting/breeding sites, not previously detected during the course of the application and provided for in this permission, are found on site. For the avoidance of doubt, it is an offence to deliberately or recklessly kill, injure or disturb protected species or to damage or destroy the breeding site of a protected species. These sites are protected even if the animal is not there at the time of discovery. Further information regarding protected species and developer responsibilities is available from NatureScot: https://www.nature.scot/professional-advice/protected-areas-and-species/protected-species

Signature: David Mudie

Designation: Area Planning Manager - South

Author: Norman Brockie

Background Papers: Documents referred to in report and in case file.

Relevant Plans: Plan 1 2139-LDN-EX-ZZ-DGA-A-001 LOCATION PLAN

Plan 2 2139-LDN-00-ZZ-DGA-A-002 PROPOSED SITE LAYOUT

PLAN

Plan 3 2139-LDN-00-00-DGA-A-003 REV P01 PROPOSED

GROUND FLOOR PLAN

Plan 4 2139-LDN-00-01-DGA-A-004 REV P01 PROPOSED FIRST

FLOOR PLAN

Plan 5 2139-LDN-00-RF-DGA-A-005 REV P01 PROPOSED ROOF

PLAN

Plan 6 2139-LDN-PL-ZZ-DEL-A-021 REV P02 PROPOSED

ELEVATION PLAN - NORTH

Plan 7 2139-LDN-PL-ZZ-DEL-A-022 REV P02 PROPOSED

ELEVATION PLAN - EAST

Plan 8 2139-LDN-PL-ZZ-DEL-A-023 REV P02 PROPOSED

ELEVATION PLAN - SOUTH

Plan 9 2139-LDN-PL-ZZ-DEL-A-024 REV.P02 PROPOSED

ELEVATION PLAN - WEST


Plan 10 DI18043-OPE-XX-XX-DR-L-900020 REV 01 LANDSCAPING PLAN

Plan 11 2139-LDN-PL-ZZ-DSE-A-011 REV P01 PROPOSED SITE SECTION PLAN

Plan 12 2139-LDN-PL-ZZ-DSE-A-012 REV P01 PROPOSED SECTION PLAN - 1-1

Plan 13 2139-LDN-PL-ZZ-DSE-A-013 REV P01 PROPOSED SECTION PLAN - 2-2

Plan 14 2139-LDN-PL-ZZ-DSE-A-014 REV P01 PROPOSED SECTION PLAN - 3 - 3

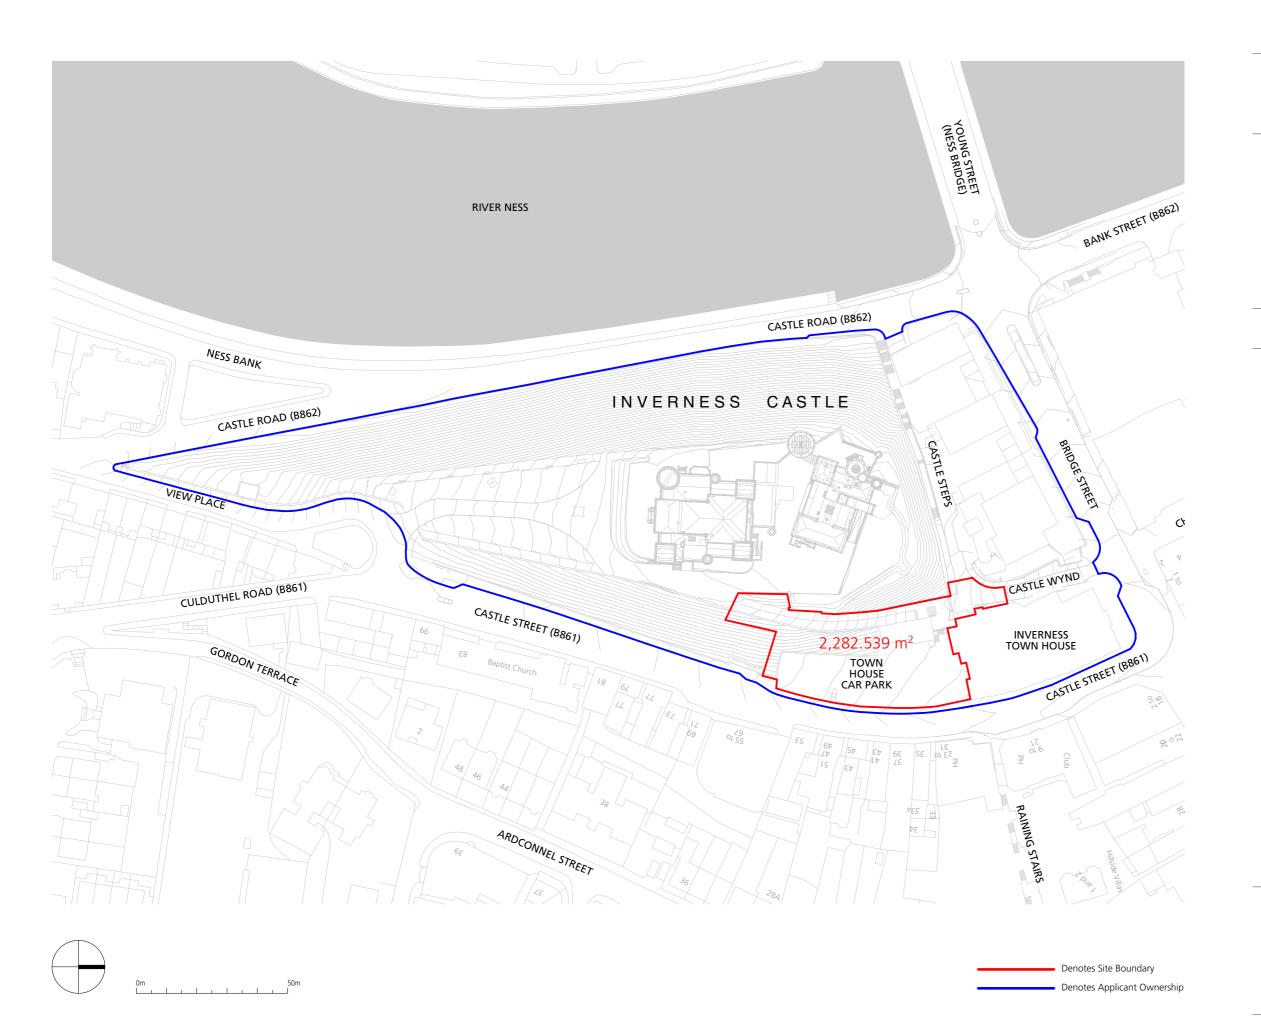

29 St Leonards Road, Forres, IV36 1EN T: 01309 673 221 E: architects@ldn.co.uk

Architect's Project No.: F2139

Sustainable Energy Centre

The Highland Council

Client's Project No.:

Information Set: (PL) Planning

Drawing No.:

2139-LDN-EX-ZZ-DGA-A-001

Drawing Title: Location Plan

Revision: P00

Revision Notes:


A1 - PLANNING PERMISSION

NOTES:

The contractor shall verify all dimensions on site and report any discrepancies in writing to LDN Architects before proceeding works.

ELECTRONIC DATA ISSUE
This drawing is read only and should not be interrogated for measurement. Use only figured dimensions and levels. All dimensions are shown in millimetres unless otherwise stated. This is a CAD produced drawing - do NOT alter manually.

 $\ensuremath{\texttt{©}}$ This Drawing is copyright of LDN Architects LLP

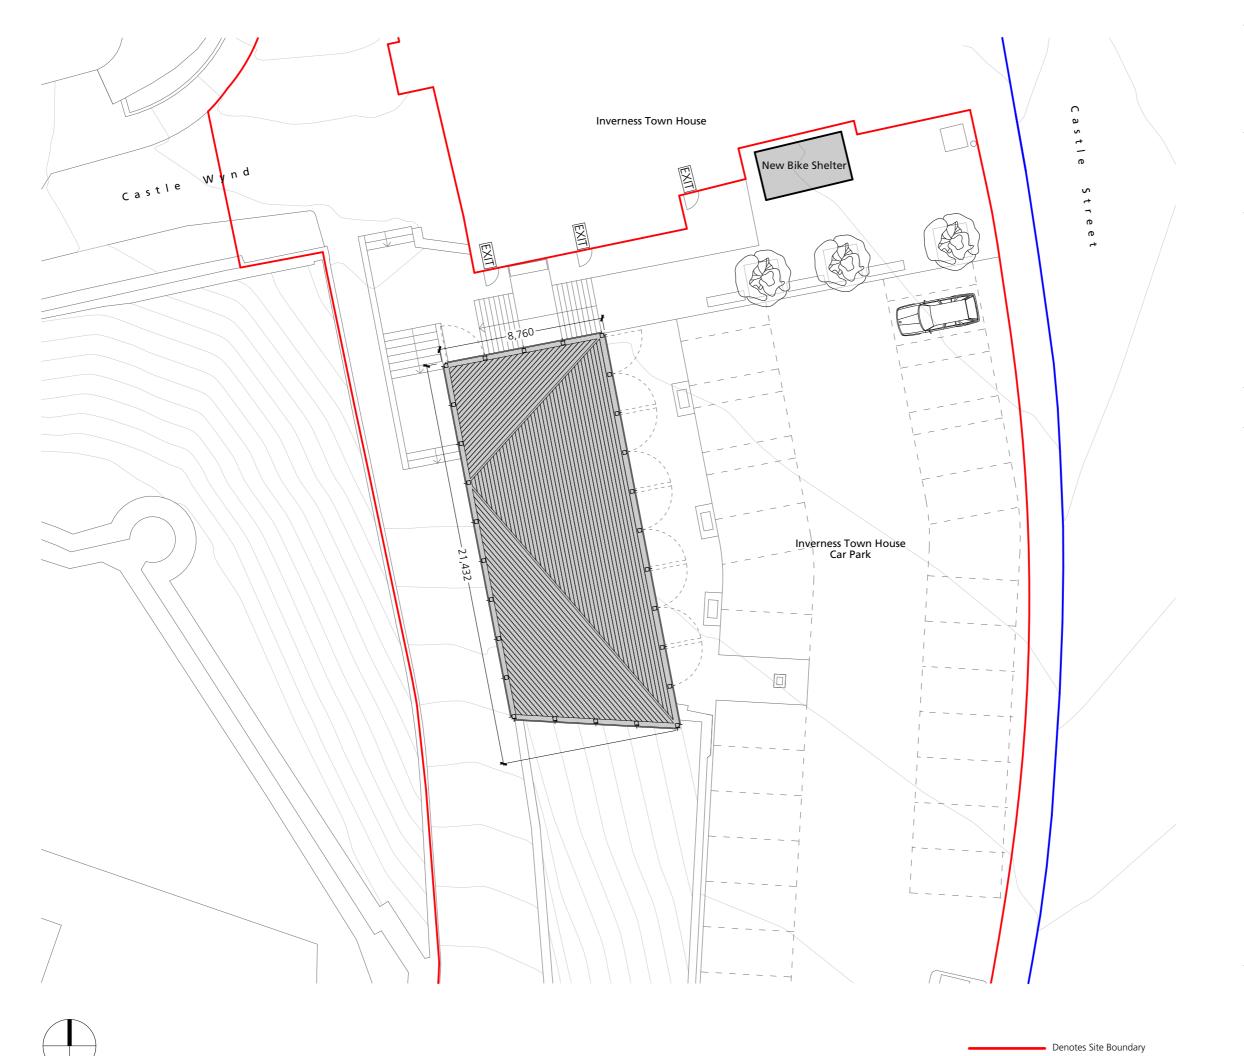

29 St Leonards Road, Forres, IV36 1EN T: 01309 673 221 E: architects@ldn.co.uk

Sustainable Energy Centre

Architect's Project No.: F2139

The Highland Council

Client's Project No.:

Information Set: (PL) Planning

Drawing No.: 2139-LDN-00-ZZ-DGA-A-002

Drawing Title:

Proposed Site Plan

Status: A1 - PLANNING PERMISSION

P00

Revision:

Revision Notes:


Rev: Date:

NOTES:

Denotes Applicant Ownership

The contractor shall verify all dimensions on site and report any discrepancies in writing to LDN Architects before proceeding works.

ELECTRONIC DATA ISSUE
This drawing is read only and should not be interrogated for measurement. Use only figured dimensions and levels. All dimensions are shown in millimetres unless otherwise stated. This is a CAD produced drawing - do NOT alter manually.

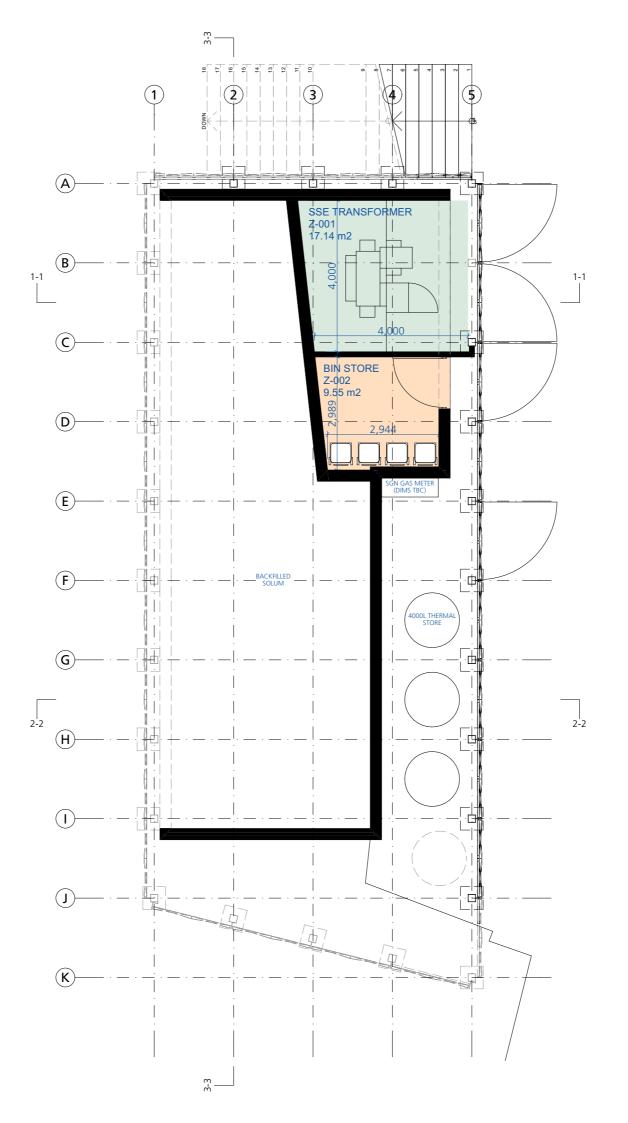



29 St Leonards Road, Forres, IV36 1EN T: 01309 673 221 E: architects@ldn.co.uk

Architect's Project No.:

Sustainable Energy Centre

F2139

The Highland Council

Client's Project No.: DI22025

> Revision: P01

(PL)

Drawing No.:

2139-LDN-PL-00-DGA-A-003

Drawing Title:

Proposed Ground Floor Plan

Status: A1 - PLANNING PERMISSION


Revision Notes:

Rev:	Date:	Description:	Drawn:	Reviewed:
P01	24.01.2023	AMEND: Floor plan updated.	RM	SM

NOTES:

The contractor shall verify all dimensions on site and report any discrepancies in writing to LDN Architects before proceeding works.

ELECTRONIC DATA ISSUE
This drawing is read only and should not be interrogated for measurement. Use only figured dimensions and levels. All dimensions are shown in millimetres unless otherwise stated. This is a CAD produced drawing - do NOT alter manually.

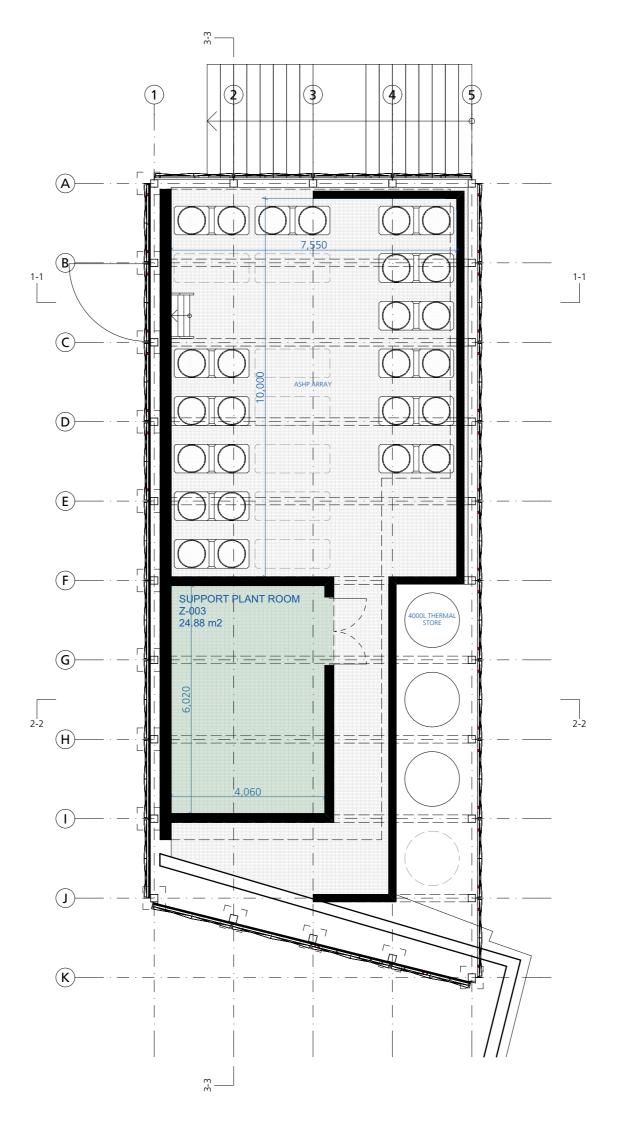



29 St Leonards Road, Forres, IV36 1EN T: 01309 673 221 E: architects@ldn.co.uk

Architect's Project No.:

Sustainable Energy Centre

F2139

The Highland Council

Client's Project No.: DI22025

(PL)

Drawing No.: 2139-LDN-PL-01-DGA-A-004

Drawing Title:

Proposed First Floor Plan

Status: A1 - PLANNING PERMISSION

Revision: P01


Revision Notes:

Rev:	Date:	Description:	Drawn:	Reviewed:
201	24.01.2023	AMEND: Floor plan updated.	RM	SM

NOTES:

The contractor shall verify all dimensions on site and report any discrepancies in writing to LDN Architects before proceeding works.

ELECTRONIC DATA ISSUE
This drawing is read only and should not be interrogated for measurement. Use only figured dimensions and levels. All dimensions are shown in millimetres unless otherwise stated. This is a CAD produced drawing - do NOT alter manually.

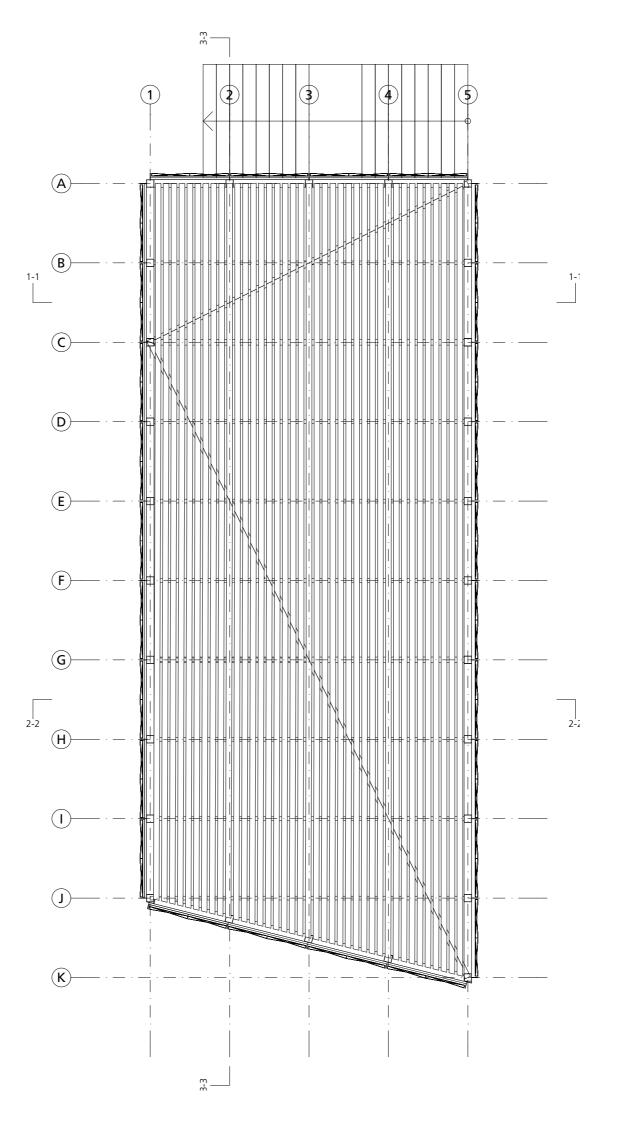



29 St Leonards Road, Forres, IV36 1EN T: 01309 673 221 E: architects@ldn.co.uk

Architect's Project No.:

Sustainable Energy Centre

F2139

The Highland Council

Client's Project No.: DI22025

(PL)

Drawing No.: 2139-LDN-PL-RF-DGA-A-005

Drawing Title:

Proposed Roof Plan

Status: A1 - PLANNING PERMISSION Revision: P01


Revision Notes:

Rev:	Date:	Description:	Drawn:	Reviewed:
P01	24.01.2023	AMEND: Roof plan updated.	RM	SM

NOTES:

The contractor shall verify all dimensions on site and report any discrepancies in writing to LDN Architects before proceeding works.

ELECTRONIC DATA ISSUE
This drawing is read only and should not be interrogated for measurement. Use only figured dimensions and levels. All dimensions are shown in millimetres unless otherwise stated. This is a CAD produced drawing - do NOT alter manually.

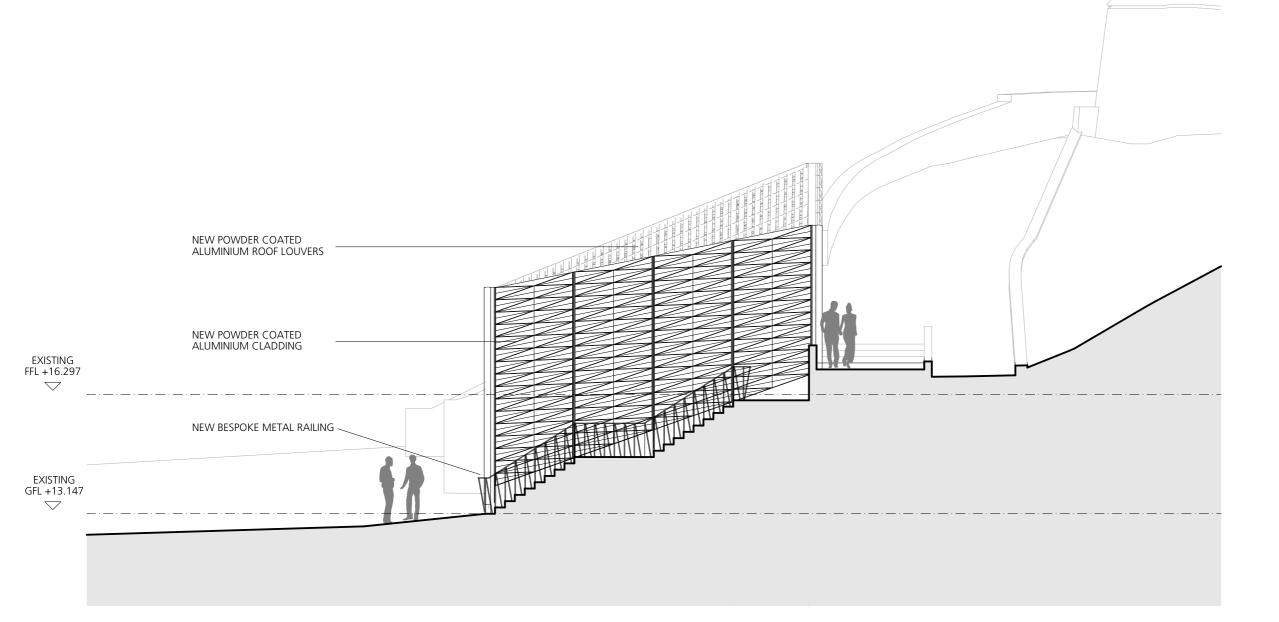

29 St Leonards Road, Forres, IV36 1EN T: 01309 673 221 E: architects@ldn.co.uk

Project: Sustainable Energy Centre

Architect's Project No.: F2139

The Highland Council

Client's Project No.: DI22025

(PL)

Drawing No.: 2139-LDN-PL-ZZ-DEL-A-021

Drawing Title:

Proposed North Elevation

Status: A1 - PLANNING PERMISSION Revision: P02


Revision Notes:

Rev:	Date:	Description:	Drawn:	Reviewed:
P01	06.01.2023	AMEND: Reduced building height.	RM	SM
P02	24.01.2023	AMEND: Existing floor levels corrected.	RM	SM

NOTES:

The contractor shall verify all dimensions on site and report any discrepancies in writing to LDN Architects before proceeding works.

ELECTRONIC DATA ISSUE
This drawing is read only and should not be interrogated for measurement. Use only figured dimensions and levels. All dimensions are shown in millimetres unless otherwise stated. This is a CAD produced drawing - do NOT alter manually.

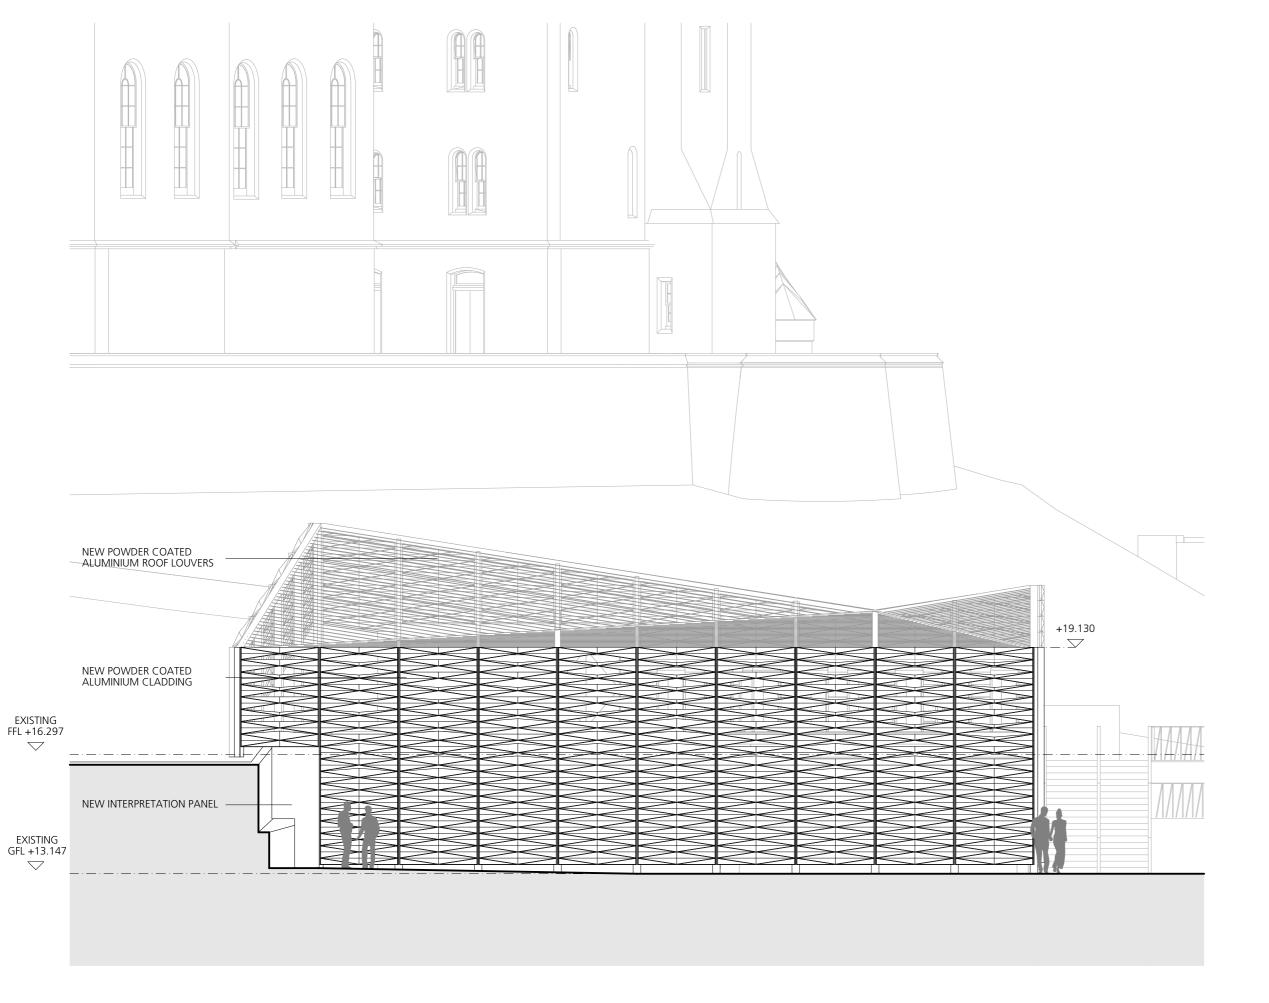

29 St Leonards Road, Forres, IV36 1EN T: 01309 673 221 E: architects@ldn.co.uk

Architect's Project No.: F2139

Sustainable Energy Centre

The Highland Council

Client's Project No.: DI22025

(PL)

Drawing No.:

2139-LDN-PL-ZZ-DEL-A-022

Drawing Title:

Proposed East Elevation

Status: A1 - PLANNING PERMISSION


Revision: P02

Revision Notes: P01 06.01.2023 AMEND: Reduced building height. P02 24.01.2023 AMEND: Existing floor levels corrected.

NOTES:

The contractor shall verify all dimensions on site and report any discrepancies in writing to LDN Architects before proceeding works.

ELECTRONIC DATA ISSUE
This drawing is read only and should not be interrogated for measurement. Use only figured dimensions and levels. All dimensions are shown in millimetres unless otherwise stated. This is a CAD produced drawing - do NOT alter manually.

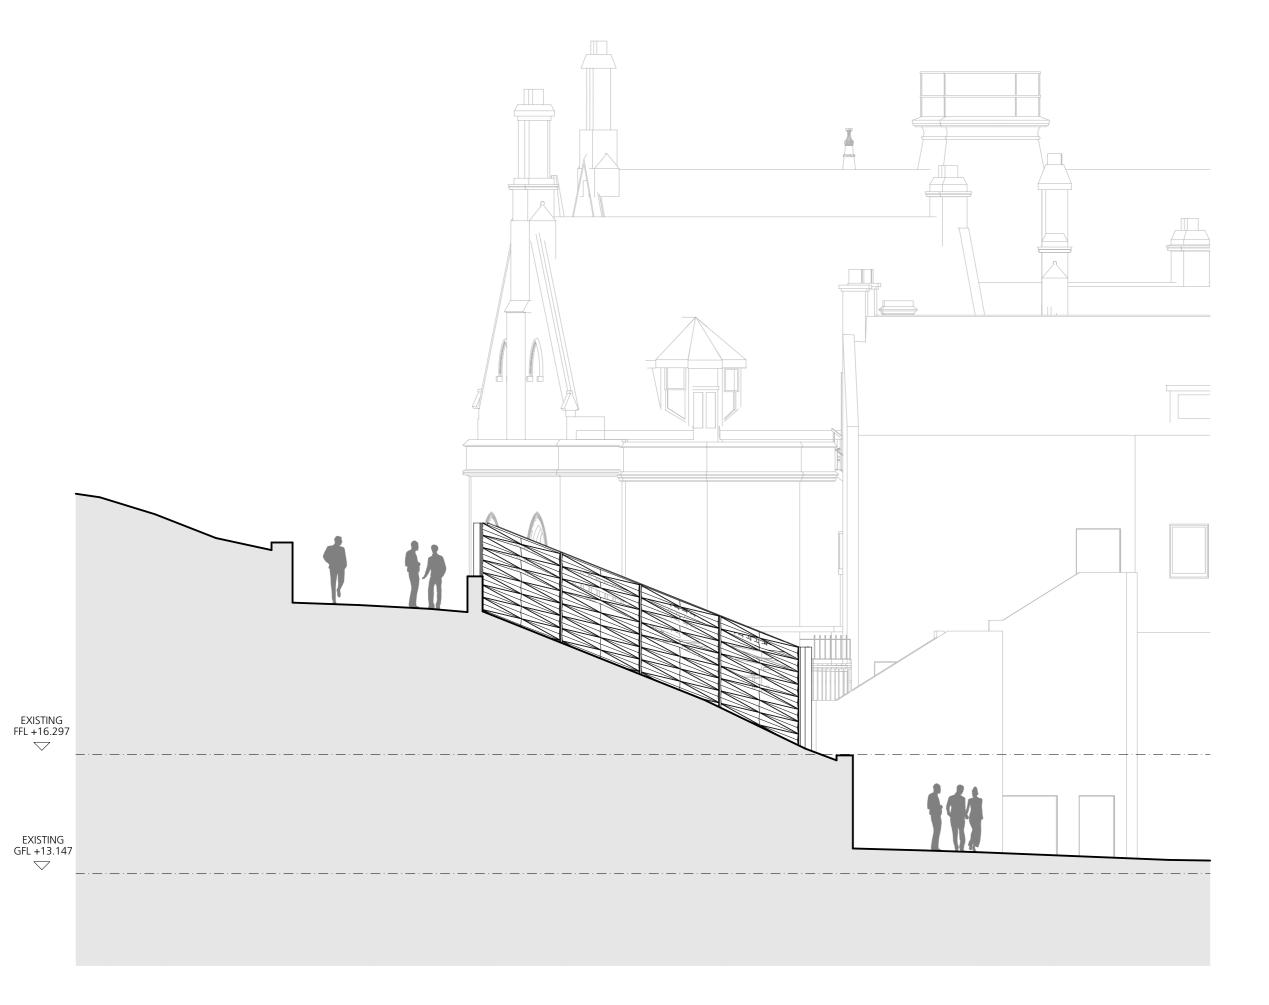

29 St Leonards Road, Forres, IV36 1EN T: 01309 673 221 E: architects@ldn.co.uk

Architect's Project No.: F2139

Project: Sustainable Energy Centre

The Highland Council

Client's Project No.: DI22025

Information Set: (PL)

Drawing No.: 2139-LDN-PL-ZZ-DEL-A-023

Drawing Title:

Proposed South Elevation

Status: A1 - PLANNING PERMISSION


Revision: P02

Revision Notes:

Rev:	Date:	Description:	Drawn:	Reviewed:
P01	06.01.2023	AMEND: Reduced building height.	RM	SM
P02	24.01.2023	AMEND: Existing floor levels corrected.	RM	SM

The contractor shall verify all dimensions on site and report any discrepancies in writing to LDN Architects before proceeding works.

ELECTRONIC DATA ISSUE
This drawing is read only and should not be interrogated for measurement. Use only figured dimensions and levels. All dimensions are shown in millimetres unless otherwise stated. This is a CAD produced drawing - do NOT alter manually.

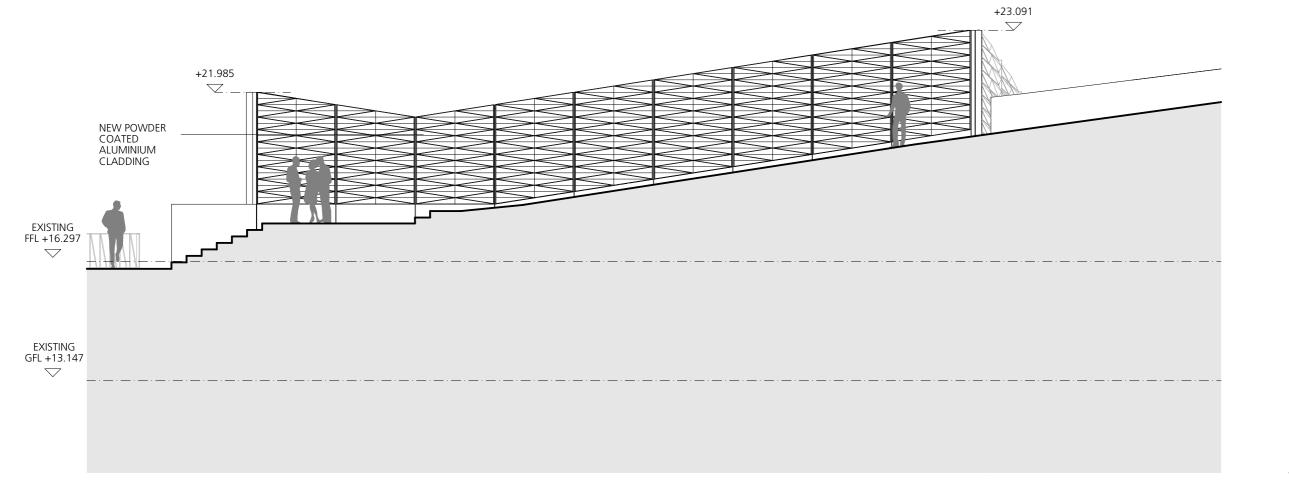

29 St Leonards Road, Forres, IV36 1EN T: 01309 673 221 E: architects@ldn.co.uk

Sustainable Energy Centre

Architect's Project No.: F2139

The Highland Council

Client's Project No.: DI22025

Information Set: (PL)

Drawing No.: 2139-LDN-PL-ZZ-DEL-A-024

Drawing Title:

Proposed West Elevation

Status: A1 - PLANNING PERMISSION


Revision: P02

Revision Notes: Rev: Date: P01 06.01.2023 AMEND: Reduced building height.

NOTES:

The contractor shall verify all dimensions on site and report any discrepancies in writing to LDN Architects before proceeding works.

ELECTRONIC DATA ISSUE
This drawing is read only and should not be interrogated for measurement. Use only figured dimensions and levels. All dimensions are shown in millimetres unless otherwise stated. This is a CAD produced drawing - do NOT alter manually.

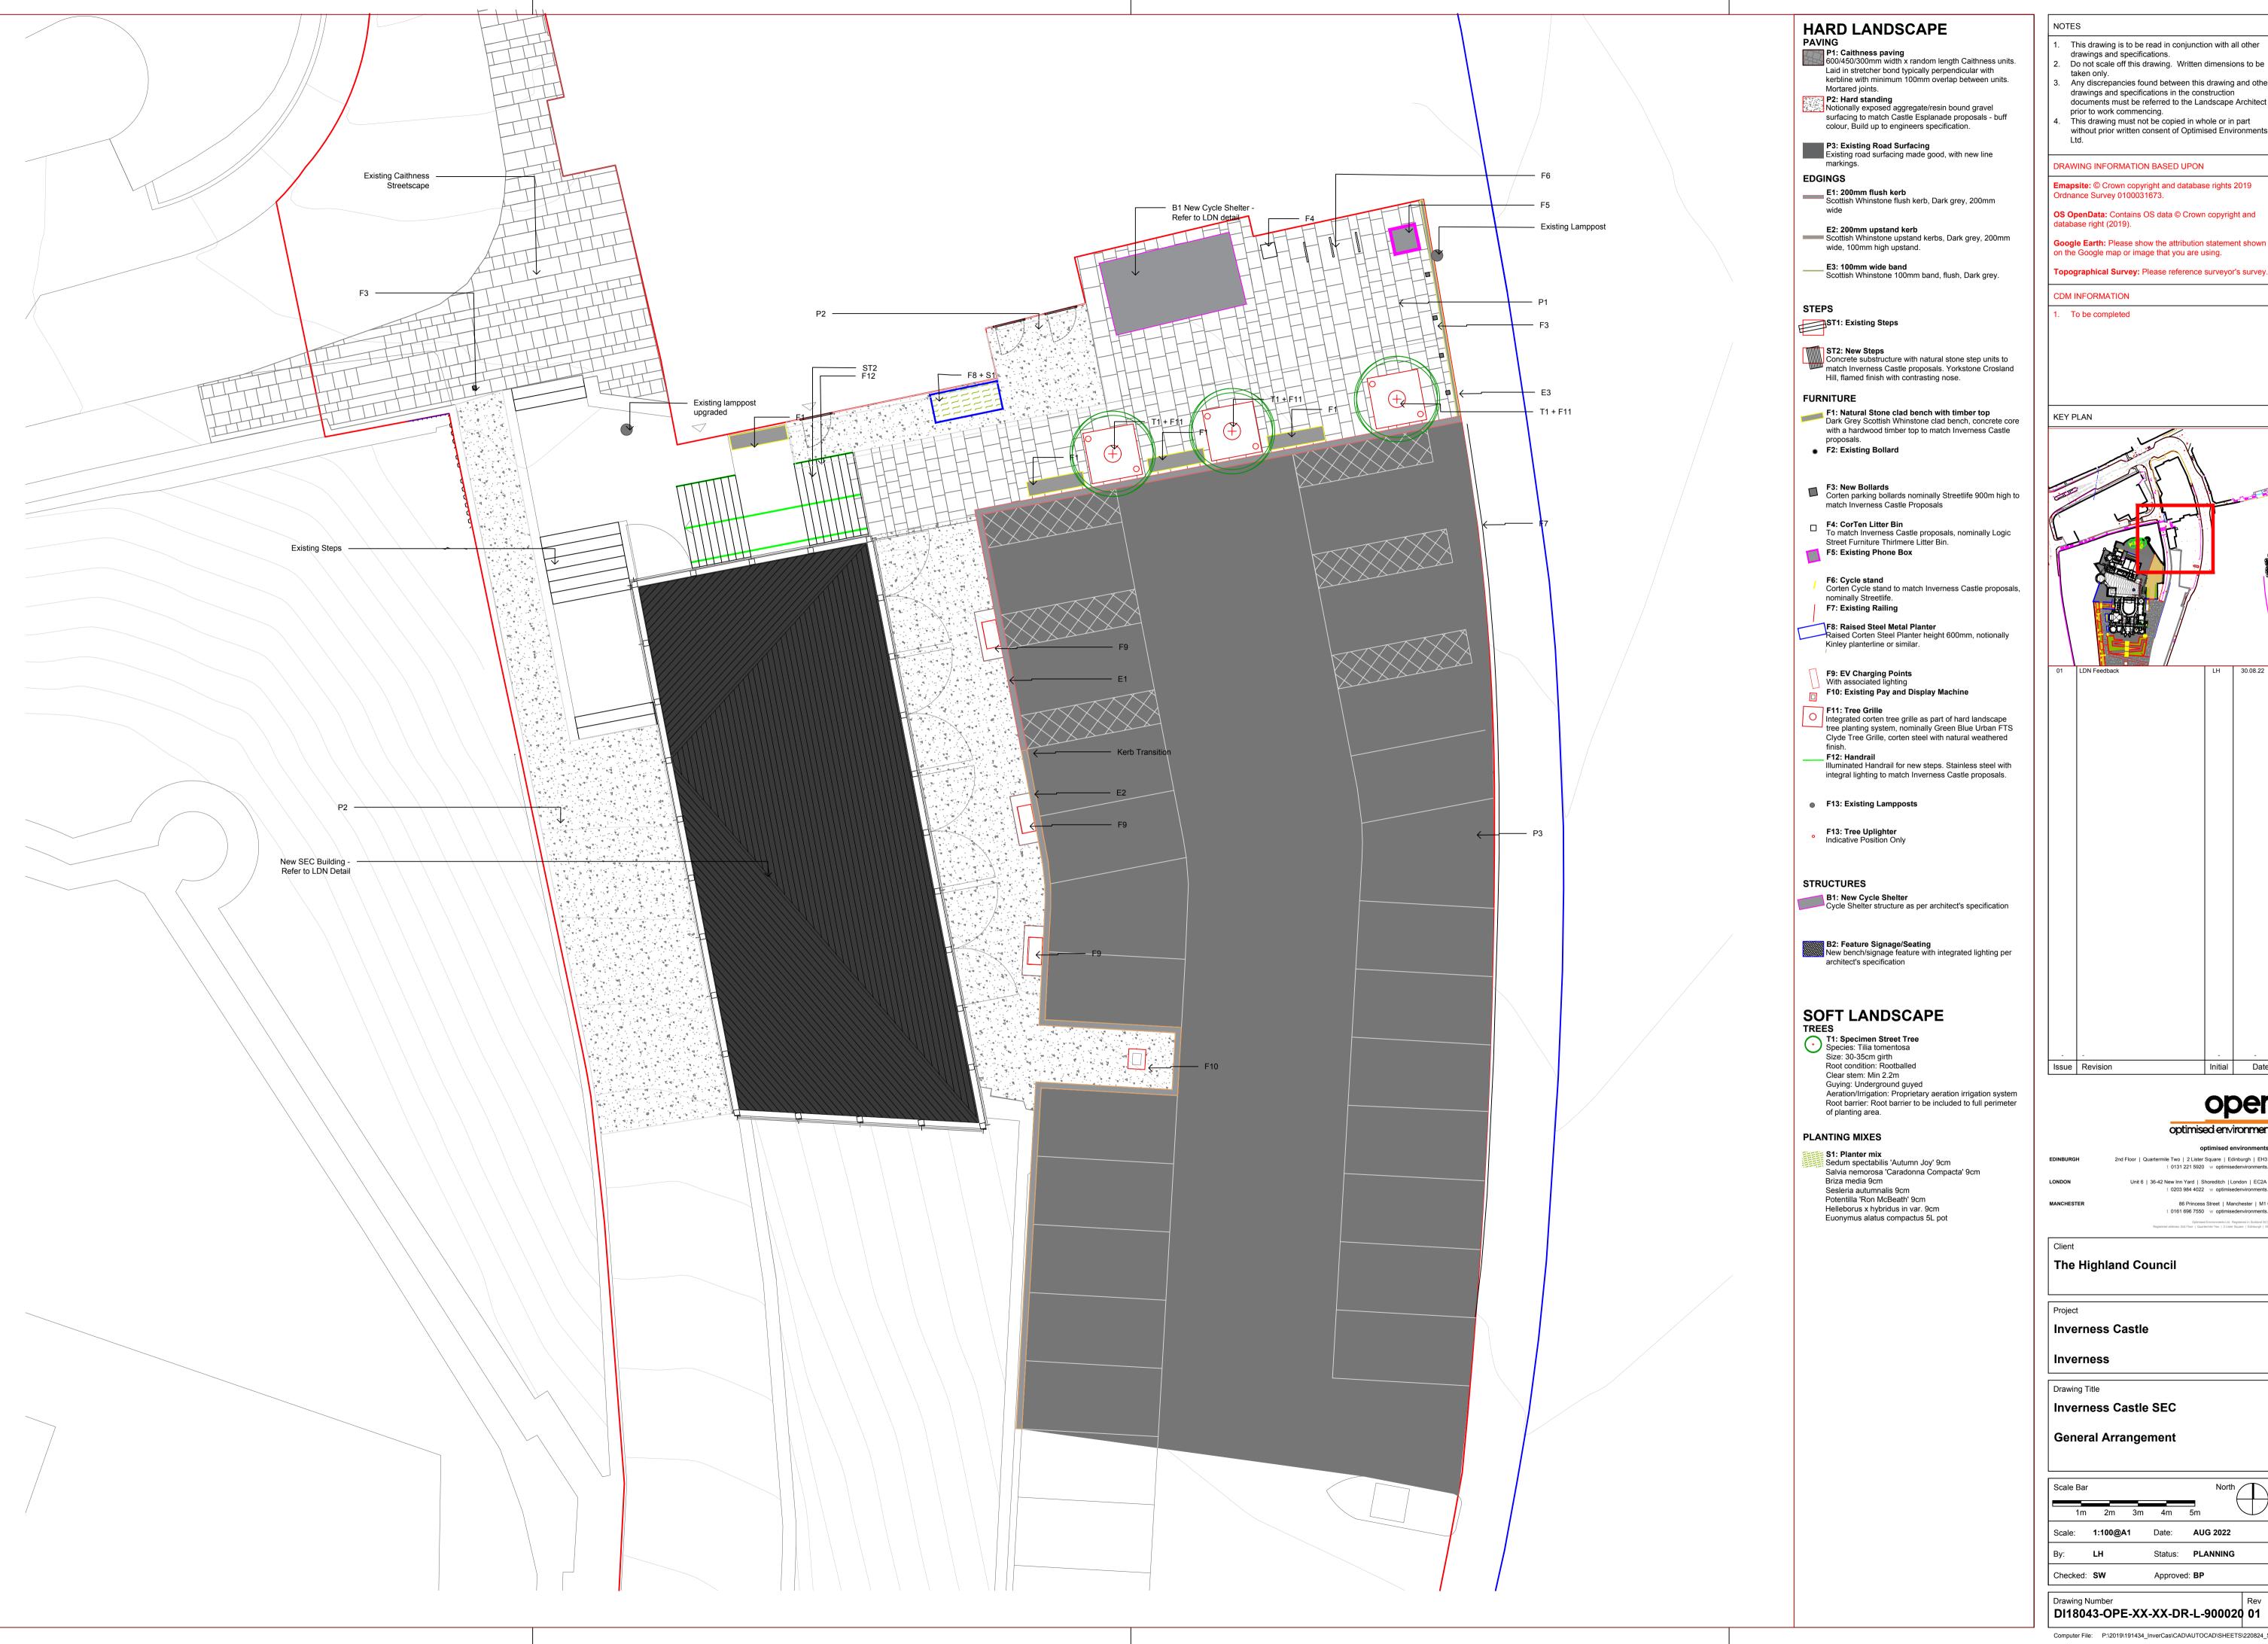

- This drawing is to be read in conjunction with all other
- drawings and specifications. Do not scale off this drawing. Written dimensions to be taken only.
- Any discrepancies found between this drawing and other drawings and specifications in the construction documents must be referred to the Landscape Architect
- prior to work commencing. This drawing must not be copied in whole or in part without prior written consent of Optimised Environments

DRAWING INFORMATION BASED UPON


Emapsite: © Crown copyright and database rights 2019 Ordnance Survey 0100031673.

OS OpenData: Contains OS data © Crown copyright and database right (2019).

Google Earth: Please show the attribution statement shown on the Google map or image that you are using.

CDM INFORMATION

To be completed

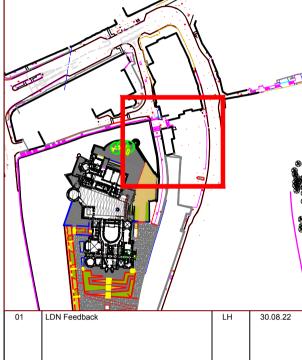

optimised environments

Initial Date

2nd Floor | Quartermile Two | 2 Lister Square | Edinburgh | EH3 9GL t 0131 221 5920 w optimisedenvironments.com Unit 6 | 36-42 New Inn Yard | Shoreditch | London | EC2A 3EY

Optimised Environments Ltd. Registered in Scotland SC359690.

Registered address: 2nd Floor | Quartermile Two | 2 Lister Square | Edinburgh | EH3 9GL

t 0203 984 4022 w optimisedenvironments.com 86 Princess Street | Manchester | M1 6NG t 0161 696 7550 w optimisedenvironments.com

Inverness Castle

Inverness

Drawing Title


Inverness Castle SEC

General Arrangement

North 1m 2m 3m 4m 5m Scale: 1:100@A1 Date: AUG 2022 Status: PLANNING

Drawing Number DI18043-OPE-XX-XX-DR-L-900020 01

Computer File: P:\2019\191434_InverCas\CAD\AUTOCAD\SHEETS\220824_SEC

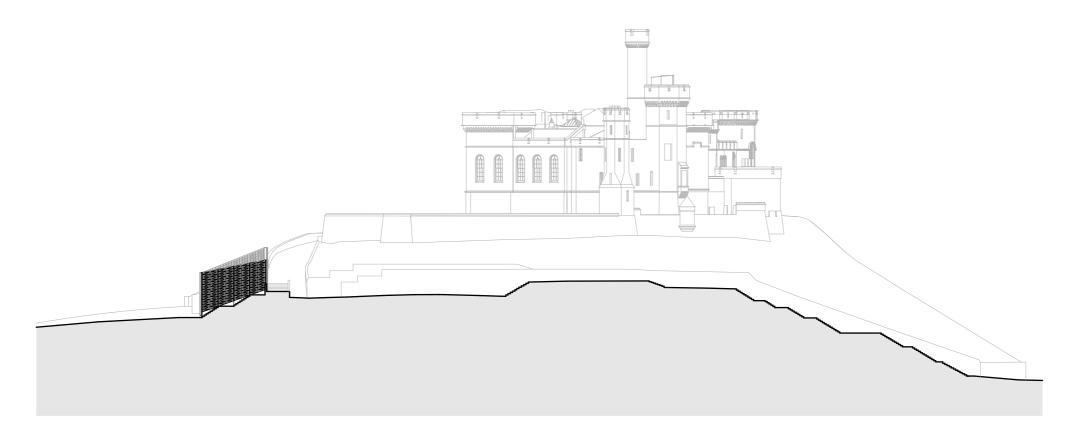

1:500 SECTION THROUGH CASTLE STAIRS

29 St Leonards Road, Forres, IV36 1EN T: 01309 673 221 E: architects@ldn.co.uk

Architect's Project No.:

Sustainable Energy Centre

The Highland Council

Client's Project No.: DI22025

F2139

(PL)

Drawing No.:

2139-LDN-PL-ZZ-DSE-A-011

Drawing Title:


Proposed Contextual Sections

A1 - PLANNING PERMISSION

Revision: P01

Revision Notes:

ev:	Date:	Description:	Drawn:	Reviewed:
01	24.01.2023	AMEND: Reduced building height.	RM	SM

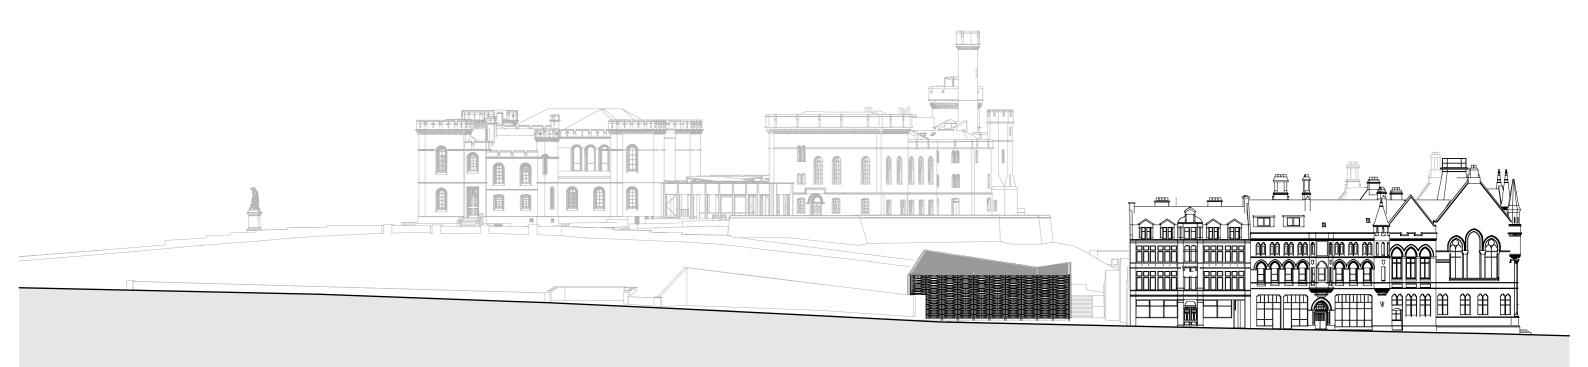


1:500 SECTION THROUGH CASTLE STREET

NOTES:

The contractor shall verify all dimensions on site and report any discrepancies in writing to LDN Architects before proceeding works.

ELECTRONIC DATA ISSUE
This drawing is read only and should not be interrogated for measurement. Use only figured dimensions and levels. All dimensions are shown in millimetres unless otherwise stated. This is a CAD produced drawing - do NOT alter manually.

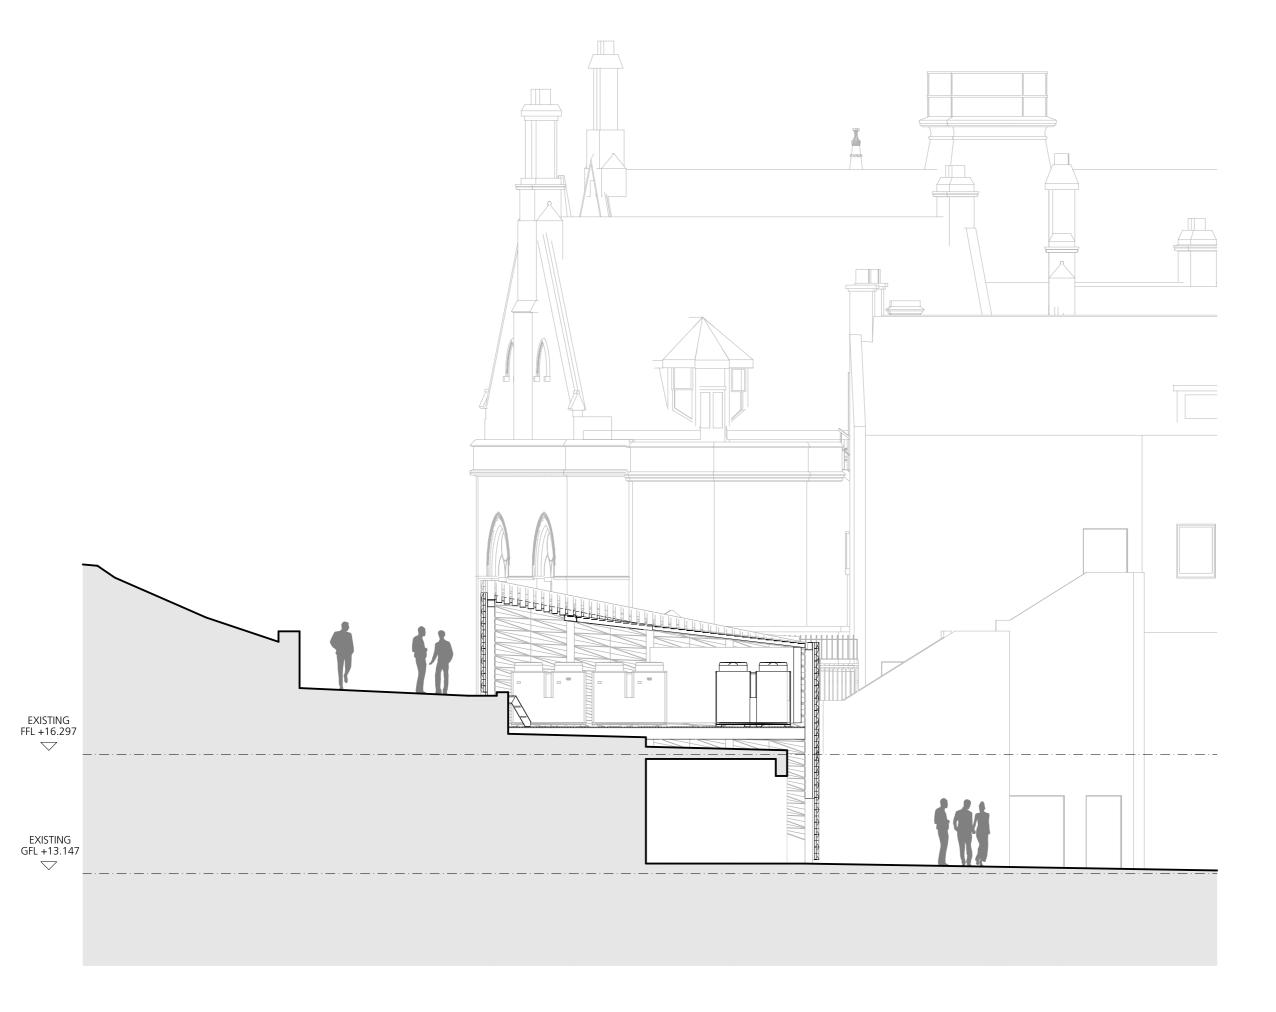

29 St Leonards Road, Forres, IV36 1EN T: 01309 673 221 E: architects@ldn.co.uk

Architect's Project No.: F2139

Project: Sustainable Energy Centre

Client's Project No.: The Highland Council DI22025

Information Set: (PL)

Drawing No.: 2139-LDN-PL-ZZ-DSE-A-012

Drawing Title:

Proposed Section 1-1


Status: A1 - PLANNING PERMISSION

Revision: P01

Rev:	Date:	Description:	Drawn:	Reviewed:
ILCVI.	sion ivotes.			

The contractor shall verify all dimensions on site and report any discrepancies in writing to LDN Architects before proceeding works.

ELECTRONIC DATA ISSUE
This drawing is read only and should not be interrogated for measurement. Use only figured dimensions and levels. All dimensions are shown in millimetres unless otherwise stated. This is a CAD produced drawing - do NOT alter manually.

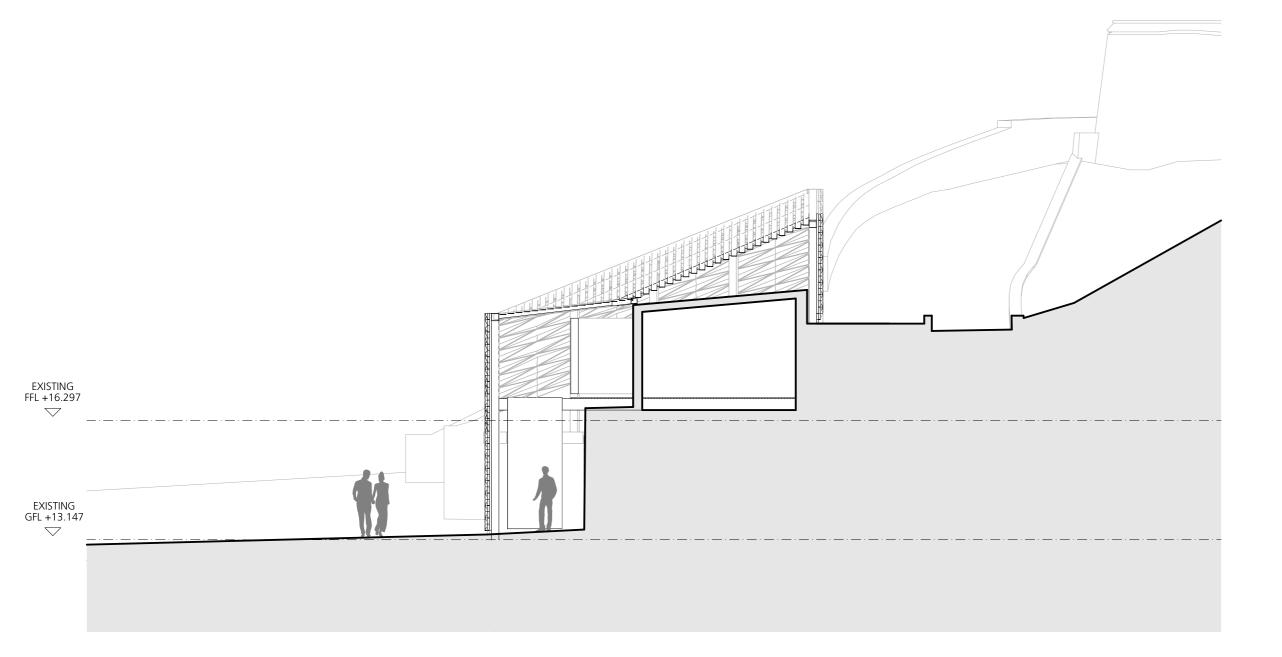

29 St Leonards Road, Forres, IV36 1EN T: 01309 673 221 E: architects@ldn.co.uk

Architect's Project No.:

Project: Sustainable Energy Centre

F2139

The Highland Council

Client's Project No.: DI22025

Revision:

Information Set: (PL)

Drawing No.: 2139-LDN-PL-ZZ-DSE-A-013

Drawing Title:

Proposed Section 2-2

Status: A1 - PLANNING PERMISSION


P01

Revision Notes:

Rev:	Date:	Description:	Drawn:	Reviewed:
P01	24.01.2023	AMEND: Reduced building height.	RM	SM

The contractor shall verify all dimensions on site and report any discrepancies in writing to LDN Architects before proceeding works.

ELECTRONIC DATA ISSUE
This drawing is read only and should not be interrogated for measurement. Use only figured dimensions and levels. All dimensions are shown in millimetres unless otherwise stated. This is a CAD produced drawing - do NOT alter manually.

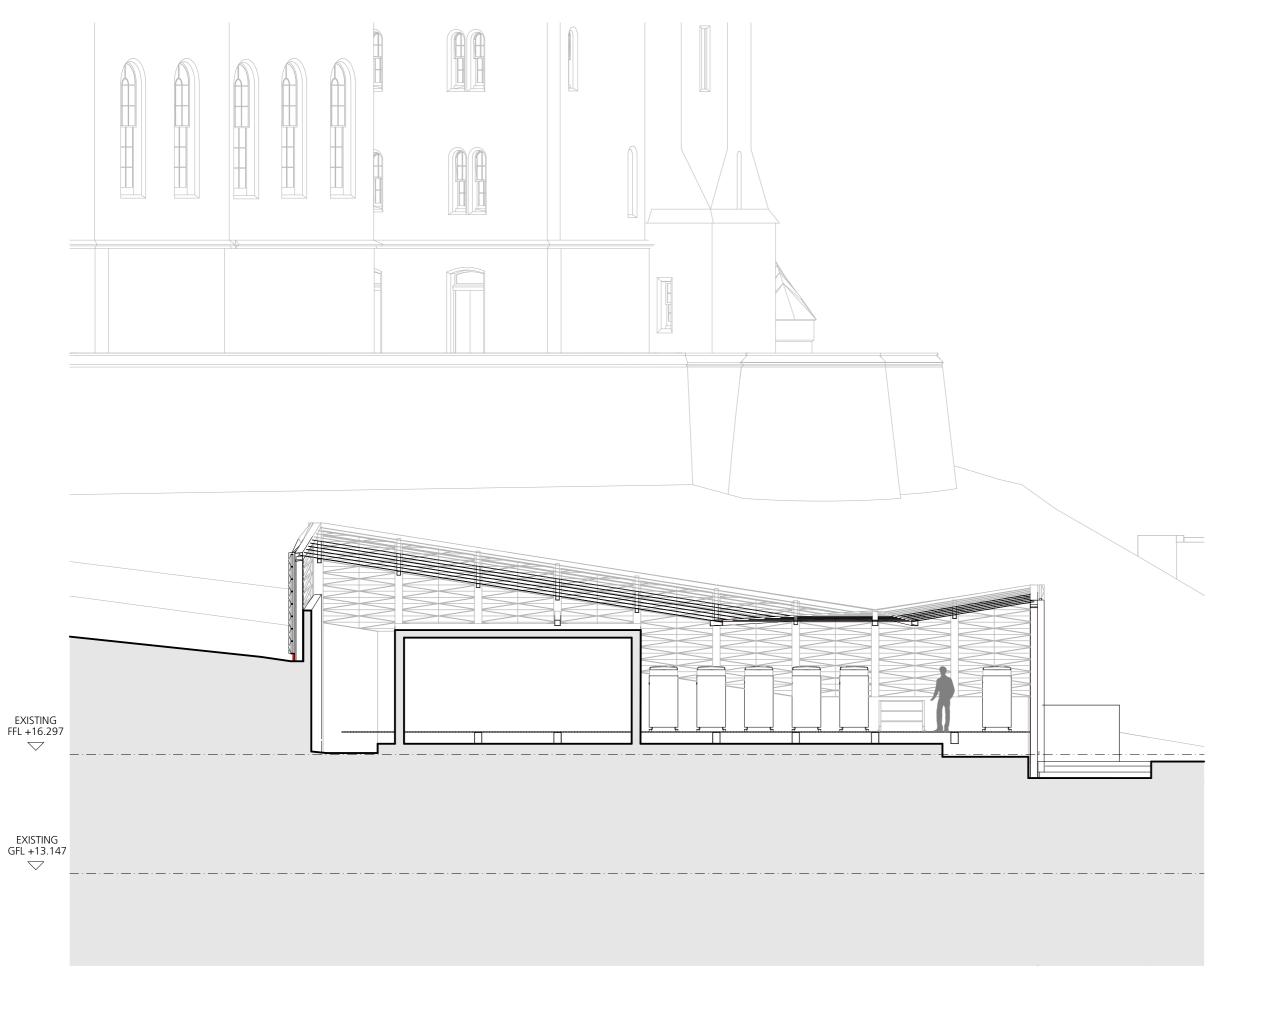

29 St Leonards Road, Forres, IV36 1EN T: 01309 673 221 E: architects@ldn.co.uk

Architect's Project No.:

Sustainable Energy Centre

The Highland Council

Client's Project No.: DI22025

F2139

Information Set: (PL)

Drawing No.: 2139-LDN-PL-ZZ-DSE-A-014

Drawing Title:

Proposed Section 3-3

Status: A1 - PLANNING PERMISSION

Revision: P01

Revision Notes:

Rev:	Date:	Description:	Drawn:	Reviewed:
P01	24.01.2023	AMEND: Reduced building height.	RM	SM

NOTES:

The contractor shall verify all dimensions on site and report any discrepancies in writing to LDN Architects before proceeding works.

ELECTRONIC DATA ISSUE
This drawing is read only and should not be interrogated for measurement. Use only figured dimensions and levels. All dimensions are shown in millimetres unless otherwise stated. This is a CAD produced drawing - do NOT alter manually.